


KEY PLAN SHOWING LAYOUT OF  
FABRICATION WORKSHOP  
HEAVY PLANT YARD



**LEGENDS**  
 PROPOSED  
 EXISTING

<b>THE BRAITHWAITE BURN &amp; JESSOP CONSTRUCTION CO. LTD. KOLKATA</b>			
TITLE: SITE PLAN OF HEAVY PLANT STORE YARD P82, TARATALA ROAD. KOLKATA-700 024			
	SIGN.	DATE	SCALE:
DRN. BY:	A.K.SETH	6.03.25	
CKD. BY:			DRG. NO.:
REV-1	APPVD. BY:		HPY/LAYOUT/01

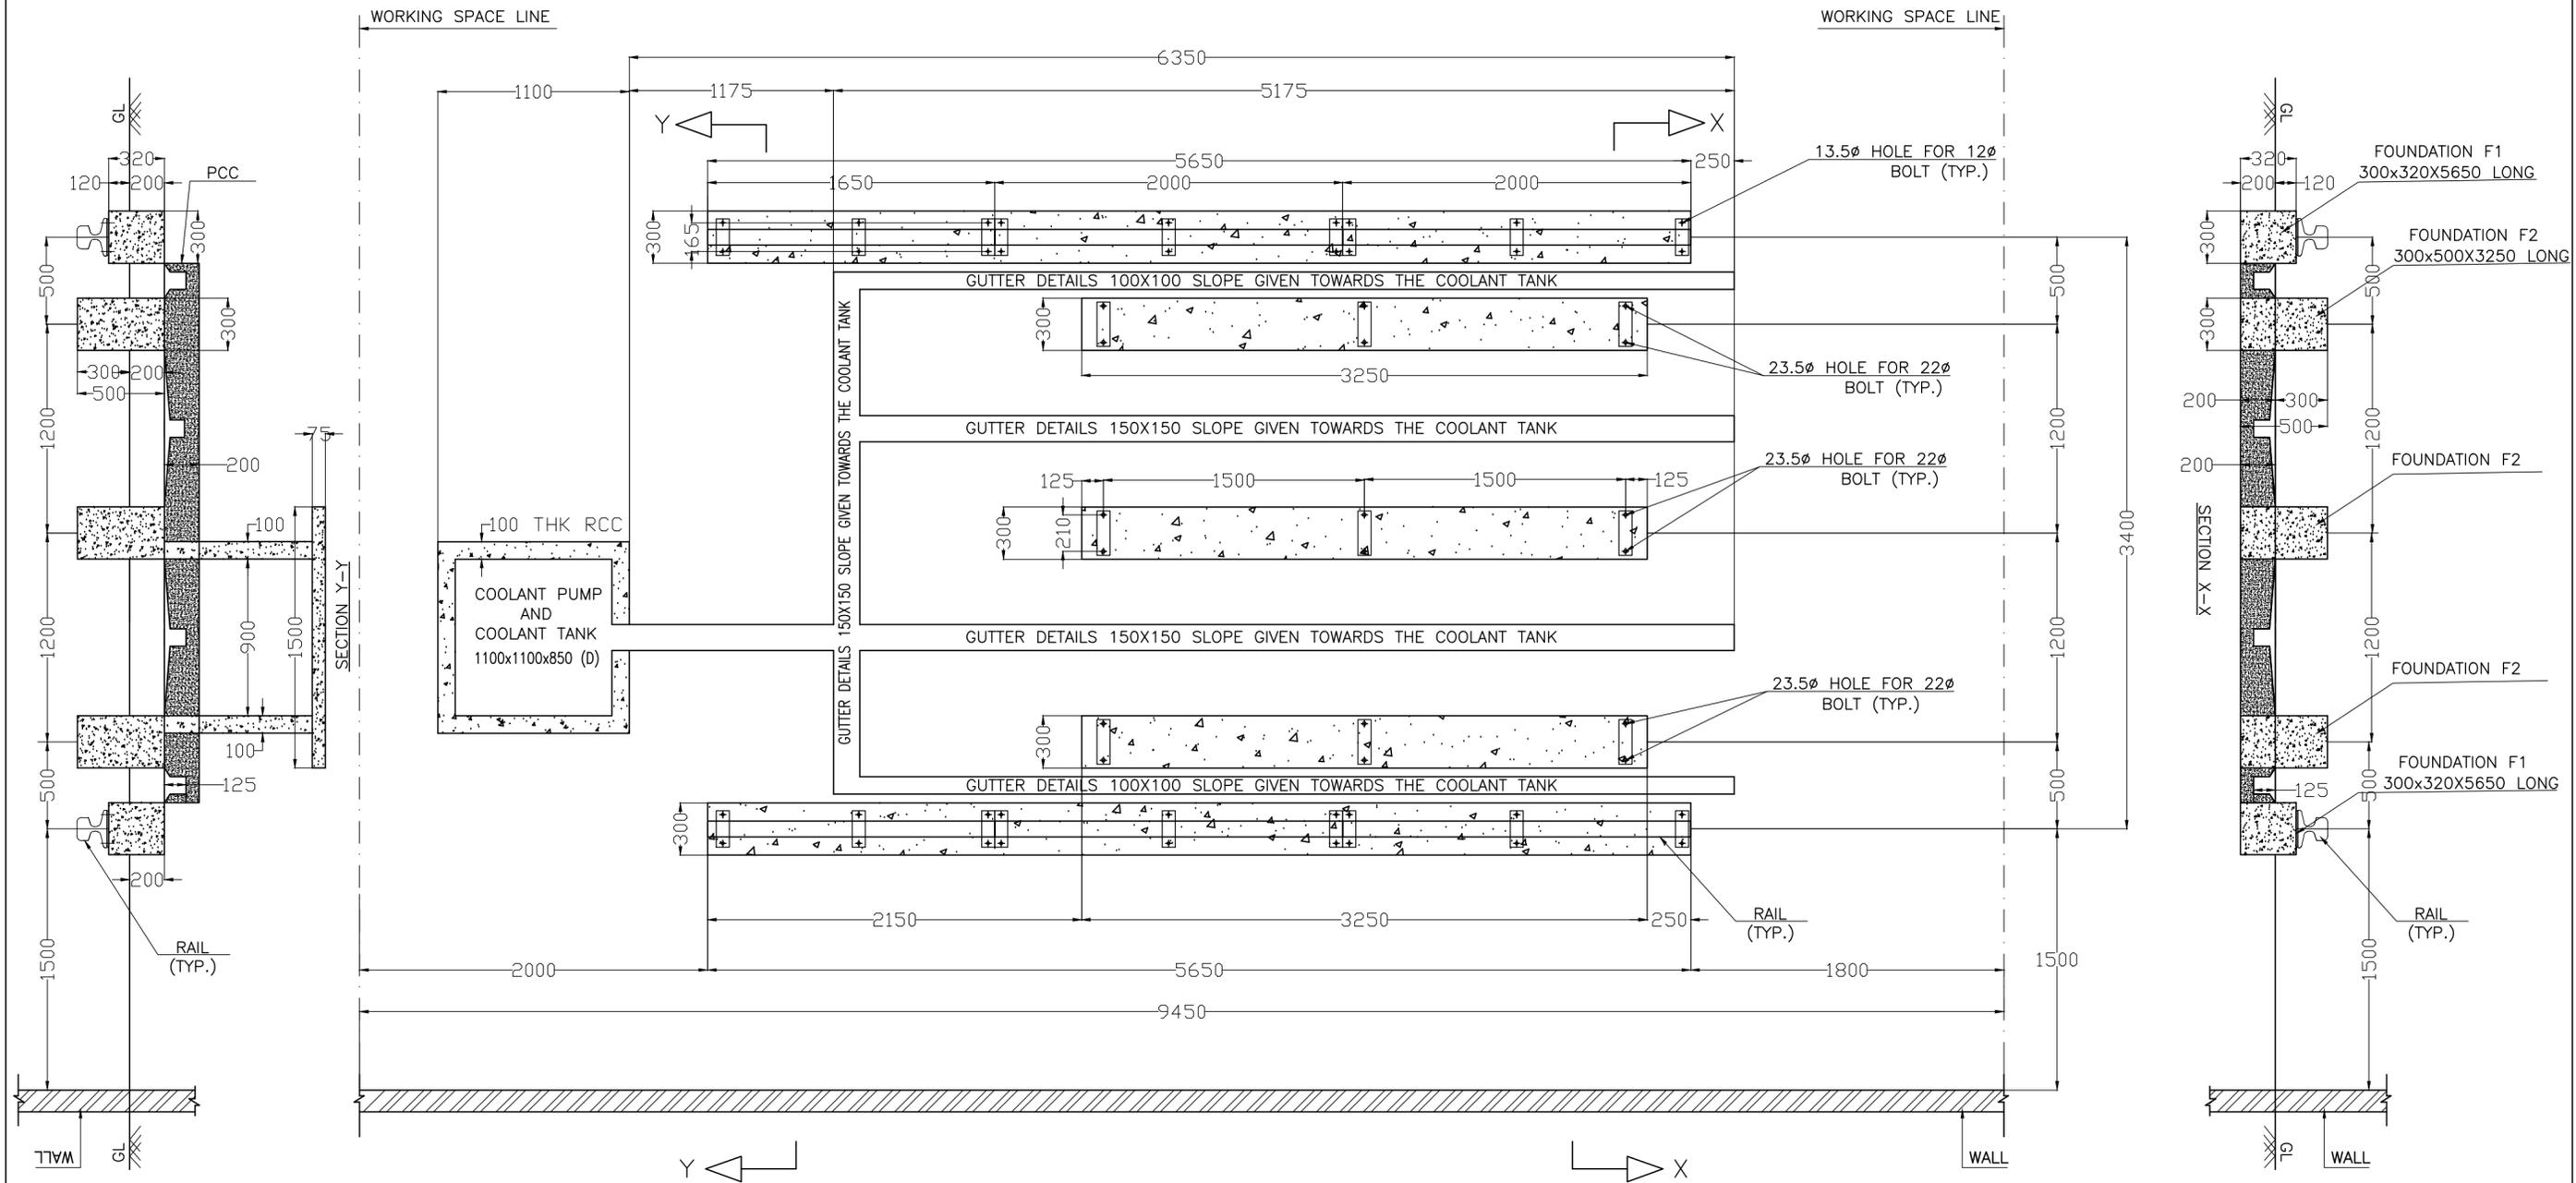


TENDER PURPOSE ONLY

- NOTE:-
- 1.) ALL DIMENSIONS ARE MM.
  - 2.) THIS DRAWING IS BASED ON PROARC DRG. NO 21 000 G 03.
  - 3.) ALL GRADE OF CONCRETE PCC (1:4:8) & RCC (1:1.5:3) .
  - 4.) GRADE OF STEEL Fe500 D.


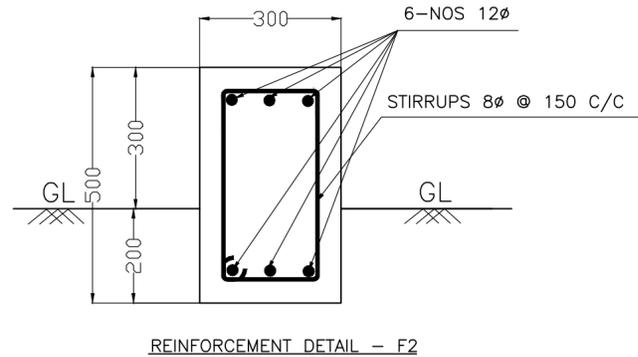
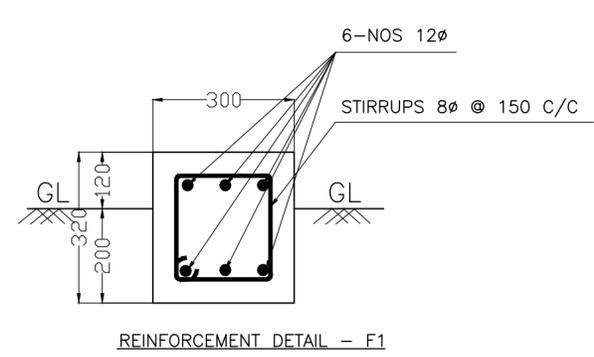


 <b>THE BRAITHWAITE BURN &amp; JESSOP CONSTRUCTION CO. LTD.</b> <b>KOLKATA</b> (A GOVT. OF INDIA INDIA ENTERPRISE)			
<b>TITLE: DETAIL OF DRILLING MACHINE FOUNDATION &amp; TABLE DETAILS</b>			
DRAWN BY:	A.K.SETH	29.07.25	ORDER NO.:
CHECKED BY:	A.K.SAHA	29.07.25	SCALE: 1:25
APPROVED BY:			
DRG. NO.-	<b>HPY/ CNC DRILL FDN./04</b>		REV. NO.

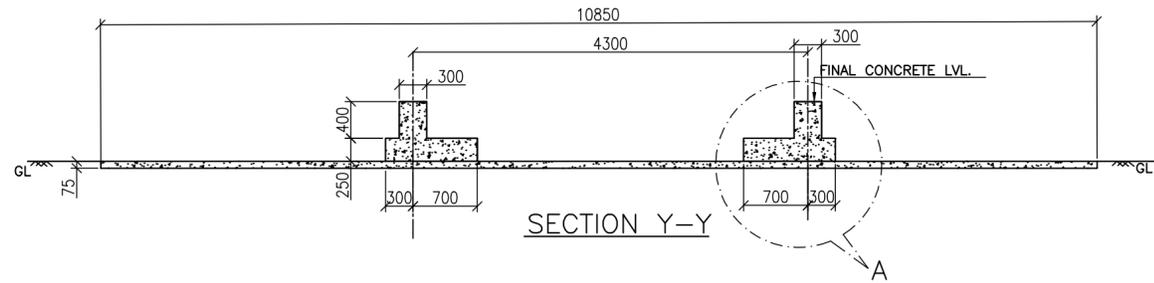


**NOTES:-**

1. ALL DIMENSION ARE IN MM.
2. CONCRETE FLOOR WIDTH 10850 MM.
3. PCC 75 MM.
4. CONCRETE RAIL STAND WIDTH 300 MM.
5. CONCRETE RAIL STAND HEIGHT 400 MM.
6. CONCRETE RAFT HEIGHT 250 MM.
7. CONCRETE RAFT WIDTH 1000 MM.
8. THIS DRAWING IS BASED ON OXYWELD ENGINEERS DRAWING NO. DRG/04/21-22.

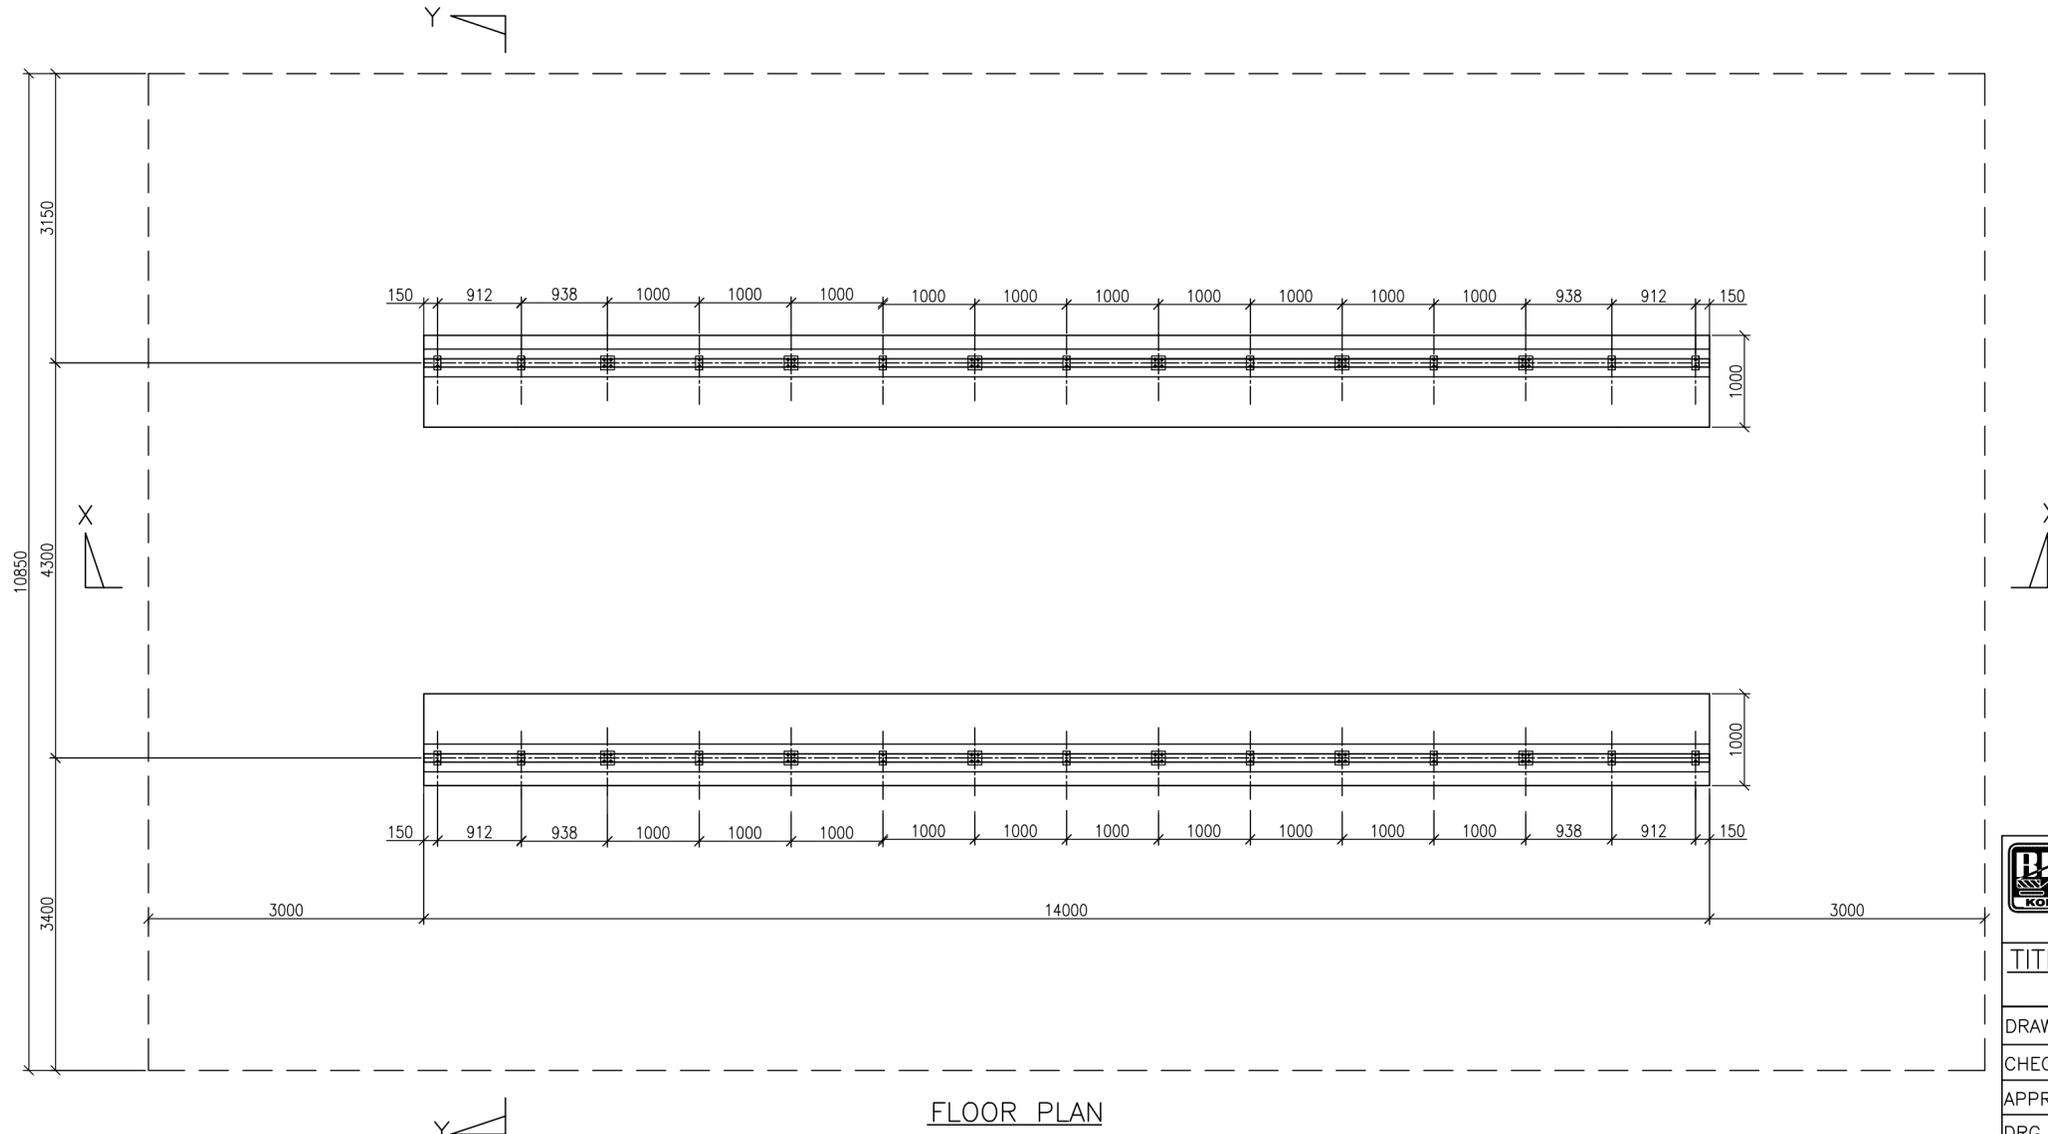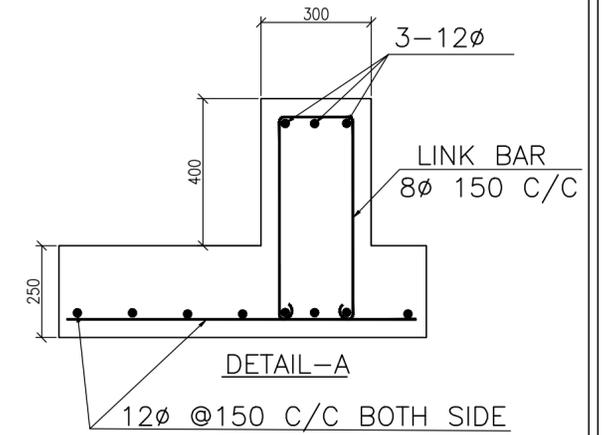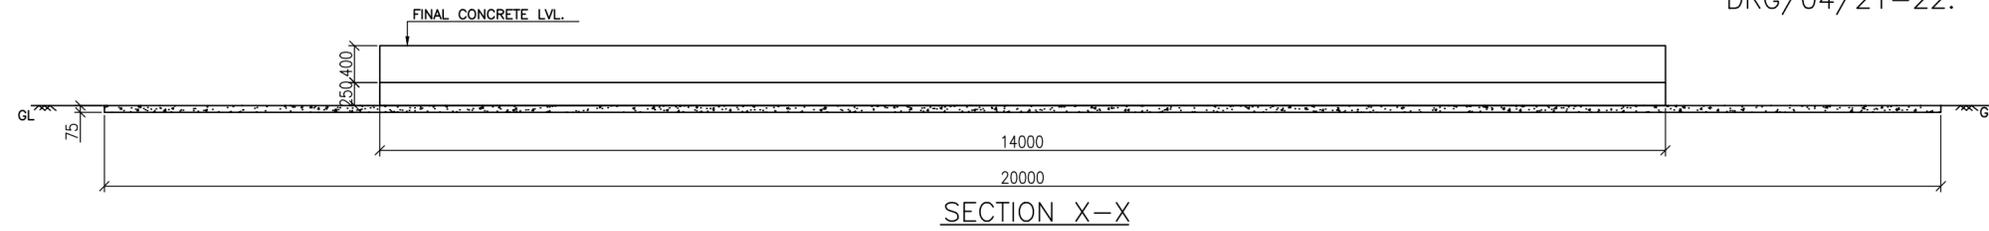


**TENDER PURPOSE ONLY**


 <b>THE BRAITHWAITE BURN &amp; JESSOP CONSTRUCTION CO. LTD.</b> <b>KOLKATA</b> (A GOVT. OF INDIA INDIA ENTERPRISE)			
<b>TITLE: FOUNDATION DETAILS FOR CNC PROFILE CUTTING MACHINE</b>			
DRAWN BY:	A.K.SETH	27.07.25	ORDER NO.:
CHECKED BY:	A.K.SAHA	27.07.25	SCALE: 1:50
APPROVED BY:			
DRG. NO. -	<b>HPY/CNC PROFILE CUTING FDN./03</b>		REV. NO.

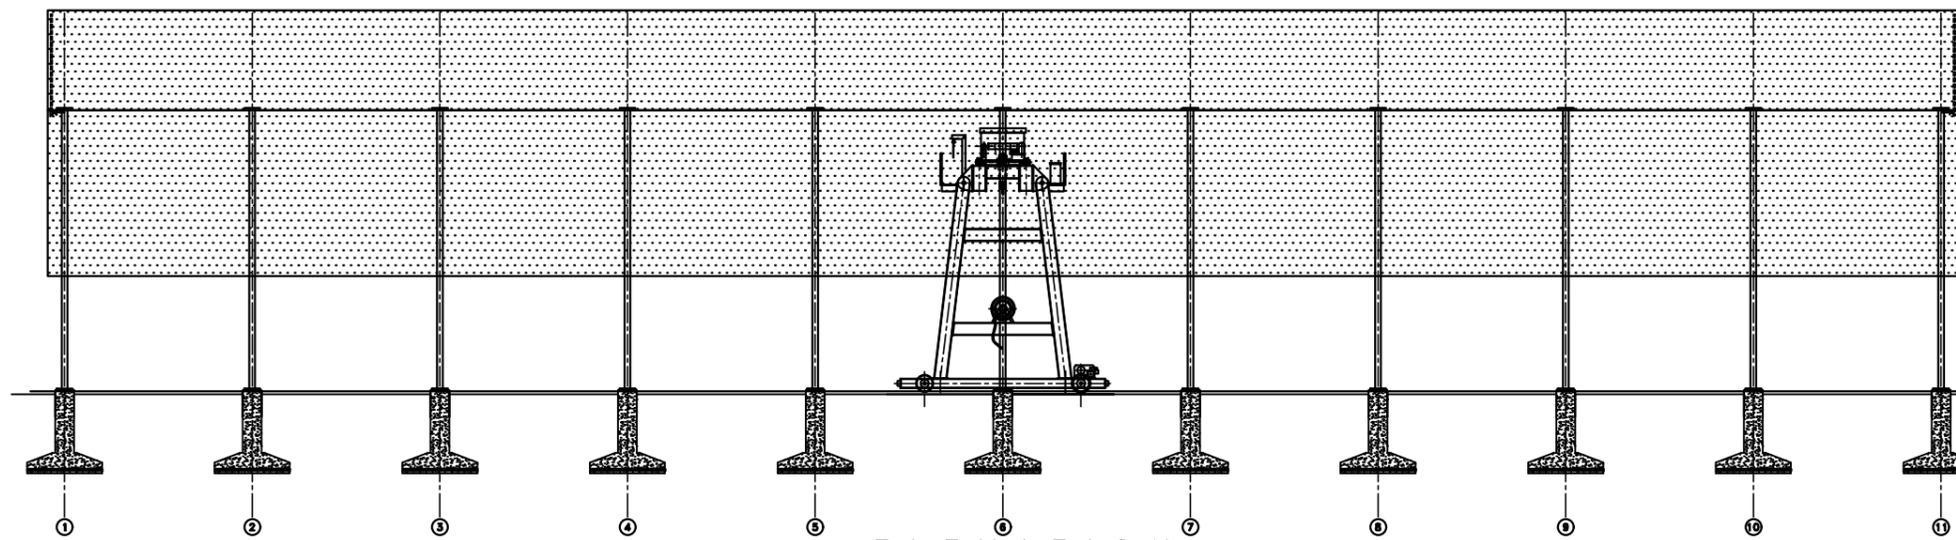

ELEVATION

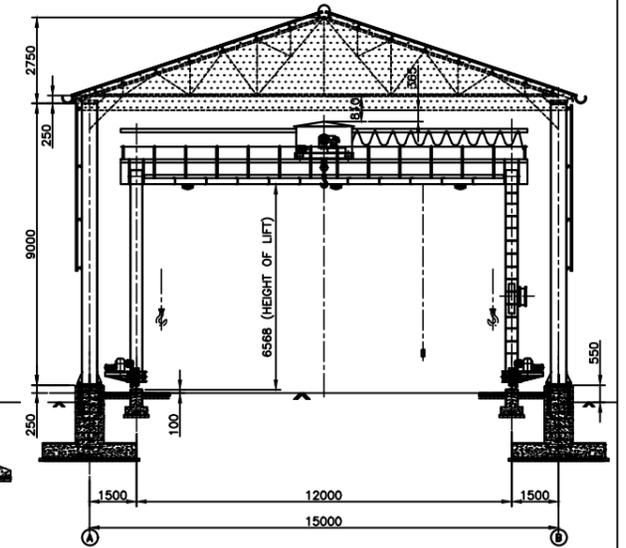

SIDE VIEW

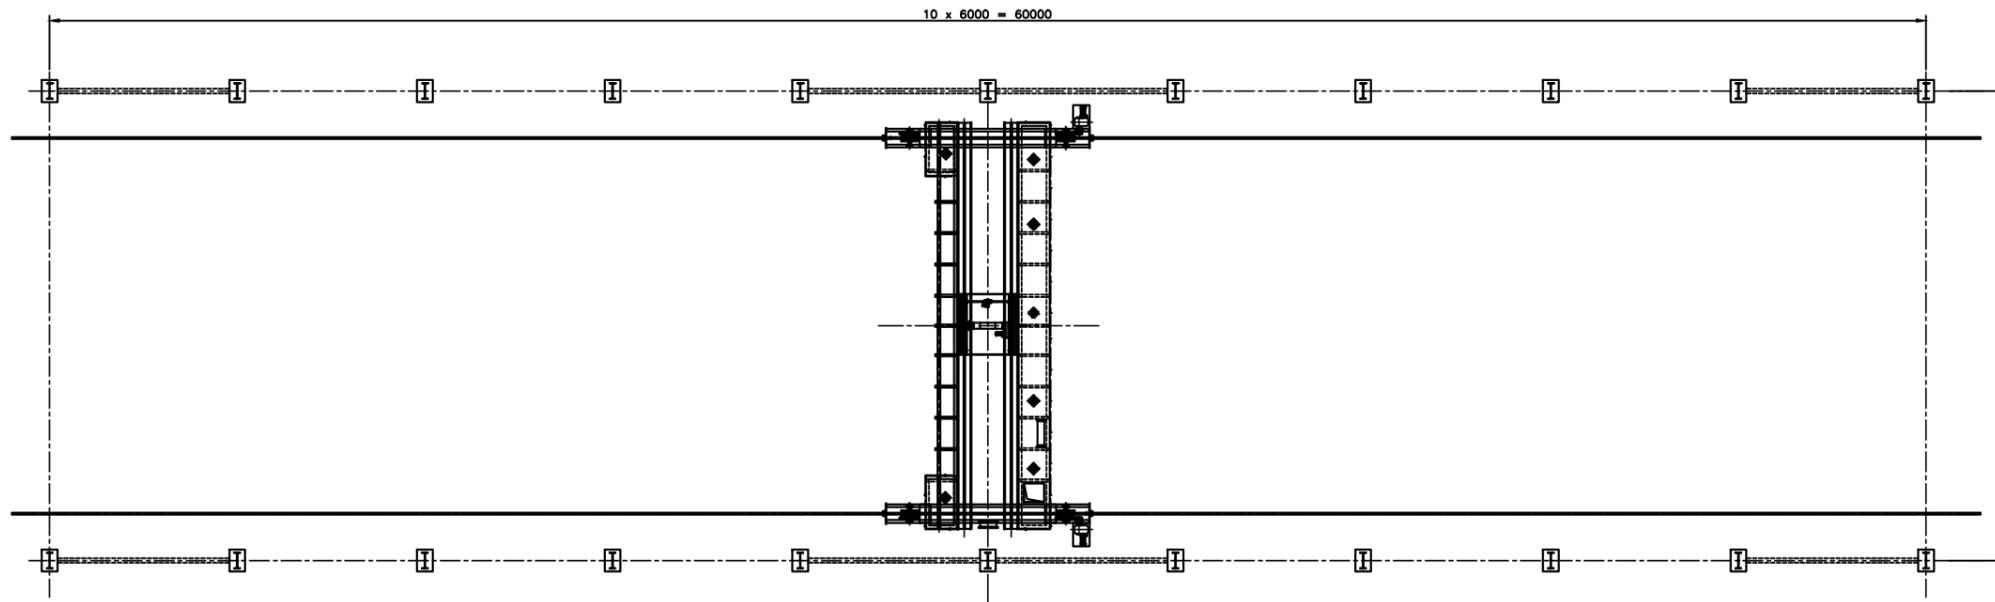

PLAN


THE BRAITHWAITE BURN & JESSOP CONSTRUCTION CO. LTD  
KOLKATA

TITLE:  
SCHEMATIC DRAWING OF ELECTRICALLY OPERATED  
DOUBLE GIRDER TYPE GANTRY CRANE FOR H.P.Y.

CAD CODE:	HPY-SK-02	ORDER NO.:	
DRAWN BY:	R. BOSE	24.11.05	
CHECKED BY:	A. SAHA		SCALE: 1:20
APPROVED BY:			
BBJ DRG. NO.:	HPY-SK-02		REV NO.

REV.	DATE	DESCRIPTION	BY
REVISIONS			

Sheet thickness 1.6 mm  
Base channel 75x40x5 mm  
Pannel size 1675(h)x1050(w)x400(d) mm

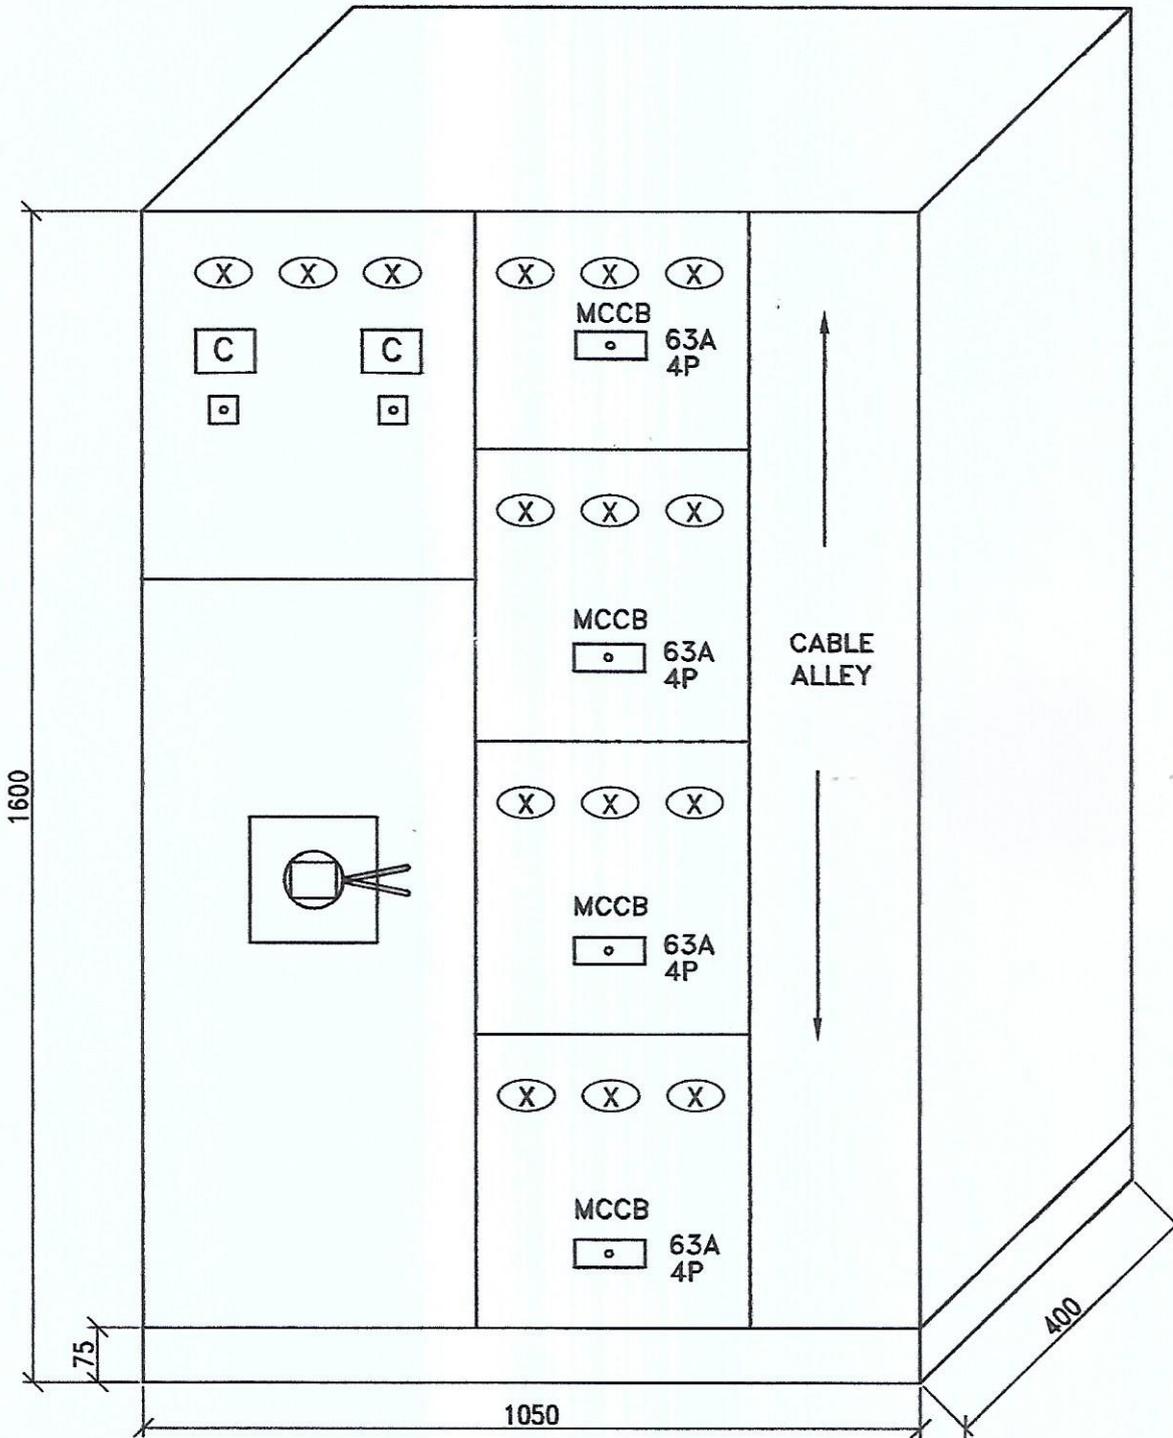

SCHEMATIC DIAGRAM OF DB PANEL